# **Supporting Documentation Latchford St James - Access ramp**

#### Note to parish

This bundle includes all the supporting documentation to your faculty application as required under Rule 5.5 of the Faculty Jurisdiction (Amendment) Rules 2019.

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Caroline Hilton, DAC Secretary



19 May 2023

#### We petition the Court for a faculty to authorise the following-

Please describe the works or other proposals for which a faculty is sought in the way recommended by the Diocesan Advisory Committee in its Notification of Advice.

the Diocesan Advisory Committee in its Notification of Advice.					
SCHEDULE OF WORKS OR PROPOSALS					
Installation of disabled access ramp to church entrance.					
Copies of the Standard Information Form and any drawings, plans, specifications, photographs or other documents showing the proposals must be provided with this petition.					



#### ST. JAMES, LATCHFORD: WORKS TO PROVIDE DISABLED ACCESS: STATEMENT OF SIGNIFICANCE

#### 1.00 THE CHURCH IN ITS URBAN ENVIRONMENT.

#### 1.01 The Setting of the Church

The Church of St. James, Latchford, sits on a relatively level site immediately south-west of a major roundabout at the junction of the A49 Wilderspool Causeway with Chester Road and Park Boulevard, west of which is the River Mersey. The openness of the traffic island, the fact that the west end of the church forms the boundary with the public footpath, and the natural fall of the land to the east of the church give the building added townscape prominence. The church sits towards the northern edge of a well-defined, compact and irregular shaped churchyard, immediately abutting the eastern pavement of the A49, at National Grid ref. SJ 60785 87510.

The church is correctly orientated ecclesiastically, although its geographical axis is more south-west northeast. The principal access into the building is via a double door in the westernmost bay of the north Nave wall, which leads into a lobby which formerly contained stairs up to a long since removed gallery. A second entrance, in the corresponding southern location, appears to be largely unused. Other, single leaf, external doors giving access to the Lady Chapel in the easternmost bay of the south Nave wall, and Choir Vestry to the north of the Chancel, are also similarly little used. All the doors address a flagged path which runs around 3 No. sides of the building, linking with the Wilderspool Causeway footpath immediately south of the church and the road accessing the car park behind the building to the north. The building is Listed Grade II for the following reasons:

- Its well-preserved, simple early C19th Gothic exterior in a prominent location
- The proportions and volume of the Nave (with the former gallery stair vestibules flanking the west Tower, the lower chamber of which formerly acted as the entrance porch), and the short Chancel, all characteristic of Georgian church planning
- The quality of the later, C20th, fittings in the Chancel



Google Maps image of the church's urban setting. The bus depot to the north will be demolished for housing.

#### 1.02 The Living Churchyard

The churchyard has well defined boundaries in the form of low, local red sandstone walls, which were formerly surmounted by railings. These enclose a relatively small area of land around the north, east and south sides of the church, which, now that the churchyard is closed for burials, is maintained by the Local Authority. The west end of the building and flanking churchyard walls directly abut the Wilderspool Causeway footpath, which is also in Local Authority ownership.

Proportionally the biggest part of the churchyard comprises a triangular section of land to the south of the building, which is entered through a gated opening in the western boundary wall. This opens to a flagged path running parallel with the south Nave wall before returning around the east end of the church to link with the paving to the north. Except for the path and a landscaped bed infilling the area between the paving and the south church wall, which acts as a 'Garden of Remembrance', the area is laid to lawn, interrupted only by a mature tree near the eastern boundary.


Site restrictions suggest burials would have been confined to this area, and nothing visible within the church grounds suggests that there are any vaults. The only indication that the churchyard was formerly used for burials is the line of memorial stones set upright in the ground in front of the diagonal east boundary wall to the lawned area south of the church. This area of the churchyard does, however, provide a small oasis of green space in surroundings otherwise dominated by large areas of hardstanding.



The south churchyard with Memorial Garden against building wall and ledger stones along the east boundary.

#### 1.03 Social History

The church, dedicated to St. James the Apostle, was built to the designs of Liverpool Architect Samuel Rowland in 1826, to replace an earlier church constructed in 1777 beside the river Mersey on Knutsford Road. When consecrated in 1828 the interior of St James resembled more a non-conformist chapel than a typical Anglican church, and, whilst the exterior and masing of the building has survived largely unaltered, the interior has been much remodelled to accommodate changing preferences in the way worship is observed.

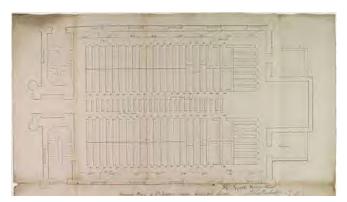


Ground floor plan showing the Tower entrance.

These linked to an organ gallery suspended in the Chancel arch, whilst towards the east end of the Nave services were conducted from a triple decker pulpit to a congregation seated in box pews.

Access to the gallery was from stairs in the vestibules to the north and south of the Tower, which now act as entrance lobbies. The communion table against the east Chancel wall, and altar rails across the Chancel entrance, would have been largely hidden from view by the pulpit.

The entrance to the church was originally in the Tower west wall, where the current Baptistery window is. A second entrance, via a Porch (now Choir Vestry) built to the north of the Chancel in 1829 to balance the Vestry to the south is the only addition to the original form of the church.

The openness of the current interior is in marked contrast to its original form, where curved fronted seating galleries ran round the north, west and south sides of the building.

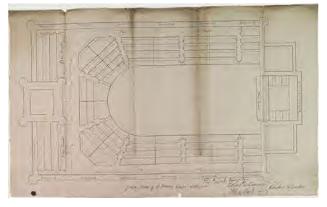

Original Plan at Gallery Level

The first internal alterations to St. James took place in the late C19th, culminating in a major reordering in 1897 to ready the building for central to high Anglican worship. In 1880 the organ was taken from its gallery over the Chancel entrance and rebuilt in the easternmost bay of the north Nave, where it remains. At the same time the triple decker pulpit was removed and an eastward facing high altar on an elevated platform positioned on the east Chancel wall.



Nave looking west towards the Tower and flanking arches denoting the former stairwells.

The 1897 works included replacing the congregation box pews with the chairs seen today, the removal of the now unsafe gallery and its access stairs, and the insertion of part height arches in the west Nave wall flanking the Tower to create lobbies in the former stairwells behind external doors each side of the building, (the former central entrance under the Tower having been closed off to form the Baptistery).

Choir pews were also installed with a central aisle, the Lady Chapel added to the south-east of the Nave, and the corresponding northern space developed to act as a Choir Vestry.


The church changed little until the 1950s and 60s when the nature of the services at St James changed to reflect modern Anglo Catholicism. Sanitary accommodation was fitted in the lobbies, the Lady Chapel was extended west, as was the Choir Vestry to balance this, a westward facing Nave altar added, and a new Chancel step and altar rails were installed in line with the extended Lady Chapel.

New Sanctuary furnishings were purchased, rendering the traditional pulpit, acquired in 1897, and eagle lectern redundant. The lectern is nowadays placed close to the Bishop's chair near the Sanctuary high altar, the traditional pulpit having been removed altogether. Above is a depiction in stained glass of the Last Supper modelled on that by Leonard de Vinci. On the reredos behind the altar the bottom section of the east window tracery has been infilled with 3 no. panels, the centre of which is a representative of Christ risen ascended and glorified and man priest and king



Wall panelling and reredos in the Sanctuary.

#### 1.04 The Church Building in General

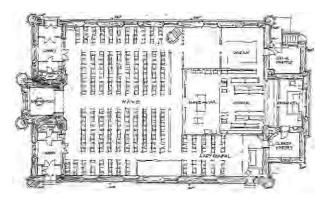

St James, Latchford: Floor Plan and Pew Layout.

St. James has a plan form which is symmetrical about an axis running from the centreline of the Tower west wall to the corresponding point of the Chancel east wall. The Tower, which projects slightly westward of the main building line, contains the Baptistery and Parish War Memorial. Each side of the Tower and separated from the main body of the Nave by part height masonry arches, the former Gallery stairwells act as Lobbies to the principal doors in the north and south walls and house the building's sanitary accommodation.

East of the Tower and Lobbies the removal of the galleries has resulted in the 5 no. bay Nave surviving as an Aisleless clear open volume, interrupted only by the low-level openwork screens enclosing the Organ Chamber / Choir Vestry and Lady Chapel. East of the Chancel arch the short Chancel is flanked by the Clergy Vestry to the South and Choir Vestry to the north, beneath which is the Heating Chamber.

Internally the walls and ceilings (except for lay in grids in the Vestries) are finished throughout in painted plaster, embellished with C20th oak panelling to the lower areas of the Chancel walls, the head moulding to which extends upwards to wrap around the reredos on the east wall. Further carved joinery work is seen in the part open screens enclosing the Lady Chapel and Organ Chamber and those separating the Nave from the former gallery stairwells. Floors are generally timber boarded, with local areas of parquet where the bases are solid in the Choir Vestry and west end of the Nave, whilst carpet is used extensively towards the east end of the church.



Screen enclosing the Lady Chapel.



The church building from the south.

The exterior language of the building is typical of simple early C19th 'Gothic', the large principal volume of the Nave being wide and tall, with octagonal clasping buttresses at each corner surmounted by pinnacles, and interrupted by the Tower at the west end, which has matching corner details. A castellated parapet runs between the Tower pinnacles, behind which is a lead flat roof. The parapets to the north and south Nave are plain, surmounted by moulded copings, which follow the roof slope to the east and west. Behind the parapets rises a duo pitched slated roof with a terracotta ridge, central to which is a ventilation structure, which drains into lead lined parapet gutters along the north and south walls.

The Chancel is similarly detailed, but is lower and lacks the corner buttresses, whilst the abutting Vestries have hipped slated roofs draining to their parapet gutters.

The building is finished externally in local red ashlar sandstone, articulated with projecting string courses at the base of the parapet and beneath the windows, and with a corbelled plinth at the base. Openings in the walls generally take the form of tall arched headed masonry lancets with plain hood moulds over and painted copper weatherings protecting the masonry cills. Those in the Nave are, somewhat unusually, inset with 3 No. light leaded glazed windows in intersecting timber tracery, while the twin lights to the Baptistery at the base of the Tower west wall, and vestries flanking the Chancel, have 'Y' tracery, also in timber. Only the triple light Sanctuary window has stone tracery.



Intersecting timber tracery at the head of the Nave windows.



Nave looking east towards the Chancel arch.

Whilst the external architecture of the building is relatively plain, internally, the sense of openness is heightened by the painted plaster walls and flat plaster ceiling on a moulded cornice which define the principal volume of the Nave, into which light floods from the tall lancet windows in the north and south walls. Screens defining the Lady Chapel and Organ Chamber / Choir Vestry are timber, with a solid base panel, above which ironwork embellishes the open timber framing. Similarly, the screens set within the masonry arches enclosing the Lobbies are part height timber, with a solid base, glazed above, and with matching doors.

Similar triple light windows in the west wall each side of the Tower light the former stairwell Lobbies, whilst the Baptistery window in the Tower west wall has cusped 'Y' tracery partly infilling the former doorway. The west wall of the Tower Ringing Chamber has a blocked rose window set in a stone diamond, above which, at Clock Chamber level, is a blind stone oculus, possibly the original clock face.

Twin' Decorated' lights with timber louvers are present to all faces of the bell chamber, three of which have a gilded clock face set central on the separating mullion. The Chancel window is a triple light with stone tracery, the bottom section beneath the transom having been infilled to accommodate the solid panels of the reredos.

The Vestry windows have timber 'Y' tracery set within the stone openings to the north and south, whilst steps up to an external door in the north wall give access to the Choir Vestry.



The Tower west wall.

#### 1.06 Contents of the Church



The original, relocated, organ.

With the interior being extensively remodelled in the late C19th and mid C20th to suit changes in worship from low to high church and Anglo-Catholicism little of the original church liturgical fittings and furnishing survives.

One fitting contemporary with the building is the organ, although this has been moved from its original location on a platform suspended within the chancel arch and rebuilt in its present location, in the north-east corner of the Nave, in the 1880s.

Scattered around the Nave walls are 6 no. large C19th panels depicting gospel scenes painted by the artist Alfred Hemming, which must have some value. Beneath these hang some of the 14 no. 'Stations of the Cross', which, with St. James being Anglo-Catholic, remain on permanent display.

The octagonal font, which predates the building, has head corbels beneath the bowl and was probably brought from the old church. The early C20th choir stalls have ends with blind tracery and frontal with open arcading.

The panelling at the base of the Sanctuary walls may be early C20, but the reredos is dated 1963, by Harper-Wycombe Ltd (designed by H.H. Wilson and carved by S.W. Hodges) and incorporates a Christus Rex in high-relief. A wall tablet to Rev Richard Wager Allix, first incumbent of the new church, has a sarcophagus with monogram. There are several stained-glass windows including Nativity in the south wall by Caroline Townshend and Joan Howson (1933), 1914-18 warmemorial west window, and 3 no. early C20th windows showing the Good Shepherd, Christ with Peter and John, and Christ with Mary and Martha, by Alfred O. Hemmings. The highly coloured east window, which must have been inserted after the organ loft was removed, shows the Last Supper and Ascension.



The Font.

#### 1.07 Significance of the Church and Significance for Mission

Historic England describes 'heritage assets' as having the following 4 no. heritage values, each of which require consideration when assessing the significance of churches:

- **Evidential:** The surviving physical evidence of the church, including how and when it was constructed, materials used, and how this has changed over time. Any hidden or buried elements also contribute to its evidential value.
- Historical: Any association the church may have with specific people or events, such as being designed by
  a famous architect, dedicated to a historical figure, containing a monument or tomb commemorating an
  event, built by a prominent local family who played an important role in shaping Welsh or British history,
  or during the industrial revolution, when the population of many towns and cities increased dramatically.
- Aesthetic: Is the church designed and constructed in a particular architectural style or illustrate good craftsmanship, does it relate positively to its immediate and wider environment and contribute to its landscape or townscape and the character of the area. It could be part of a coherent group of similar buildings.
- Communal: Any special meaning the church may have to its community, including its role in the local spiritual and cultural life of the community?

The levels of significance attributed to each are generally as follows:

- Exceptional: An asset important at the highest national or international levels, including scheduled ancient monuments, Grade I and II\* listed buildings and World Heritage Sites.
- **High:** A designated asset important at a national level, including Grade II listed buildings and some conservation areas.
- **Medium:** An undesignated asset important at a local to regional level, including local (non-statutory) listed buildings, some conservation areas. May include less significant parts of listed buildings.
- Low/Neutral: Structure or feature of very limited heritage or other cultural value and not defined as a heritage asset. May include later interventions to listed buildings, and buildings that do not contribute positively to a conservation area.
- Negative: Structure or feature that harms the value of a heritage asset.

Using the above criteria, the Significance of St. James can be assessed as follows:

The church has complete surviving physical evidence in its upstanding fabric, which, except for the addition of the Choir Vestry to the north of the Chancel not long after consecration, has not changed in plan form and massing since construction. All subsequent interventions have been internal, in response to changes in liturgical preferences, and whilst these late C19th and C20th restorations have significantly altered the character of the interior with the removal of galleries and fittings such as the triple decker pulpit, they are clearly legible in material and detail. For these reasons the **Evidential Value** of St. James is considered **High**.

St James was designed by Samuel Rowland (d 1844), a Liverpool architect responsible for a several secular Greek Revival buildings in his home city as well as several local churches. Drawings and photographs survive showing the former internal layouts with box pew furnishings and galleries, so detail of the original configuration of the building is not lost. The church also contains memorials to local benefactors including the first incumbent, and the War Memorial in the Baptistery beneath the Tower, where the font is believed to have been re-used from the church St. James was built to replace. Taking this into consideration St James can be said to have **High Historical Value**.

The aesthetic significance of St. James is recognised in its Grade II Listing designation. Whilst architecturally the early C19th interpretation of 'Early English' Gothic is relatively plain and lacking significant detail, (perhaps due to the architect's greater familiarity with the Greek revival style), the composition is nevertheless consistent and well balanced. The building contributes positively to the townscape, its Tower being an immediately recognisable local landmark, and whilst the tops of some of the corner pinnacles have been lost over time application of the assessment criteria above suggests the church has **High Aesthetic Value**.


St James has continually served the spiritual needs of Latchford's residents for nearly 2 no. centuries, and despite more recently being under threat of closure the building continues to fulfil a special role in local spiritual and cultural life. As such it is considered as having **High Communal Value**.

Since consecration the church building has proved capable of adapting to any amendments in mission requirements dictated by changing preferences in the way worship is observed. As we move through the C21st there is a recognition that the building must also offer flexible use by the congregation and community alike. Given the large, open, areas in the building St. James is better equipped than most to accommodate any such change in mission.

#### 2.00 THE SIGNIFICANCE OF THE AREA AFFECTED BY THE PROPOSAL

#### 2.01 Parts of the Church directly or indirectly affected by the Proposals

The proposed works to afford disabled access to the building form part of a wider scheme to reorder the west end of the church, updating the Kitchen and sanitary accommodation contained in the former stairwell lobbies, encroaching slightly into the Nave each side of the Tower to also include much needed storage. The balance of the works is under consideration, and, if implemented, will be the subject of a separate application.

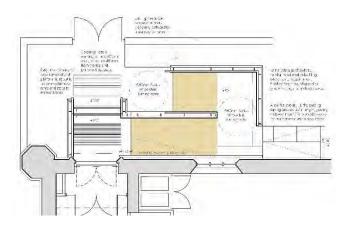

Plan of the Proposed Ramp.

The ramp addresses double doors into the former north stairwell at the west end of the Nave, which acts as the principal entrance into the church via the north Lobby. No changes are to be made to the doors or elevations of the building, other than the ramp will directly abut the north Nave wall in the area occupied by the Lobby and adjacent westernmost bay of the Nave, raising the level directly against the north Nave wall by between 90 and 340mm. At the door the existing threshold will be extended out to provide a level platform at the top of the ramp, and 2 no. 170mm steps will be introduced replacing those lost when the platform is introduced.

Available space in this area is quite constricted so a relatively small, self-seeded tree (not subject to TPO) will require removal, the roots of which have already displaced the paving to the north east of the doors, and the dog leg form to the new ramp necessitates the paving to the east of the structure to be regraded up the level of the landing (approximately 80mm) to allow maintenance access and bin removal from the area to the north east of the church.





Approximate extent of the proposed Ramp (L) and Paving displaced by roots of tree to be removed (R).


#### 2.02 Significance of These Particular Parts

Other than containing the main entrance to the church building, and addressing the west end of the north elevation, neither of which are significantly altered by the proposals, the area on which the ramp stands can be said to have **Low / Neutral** significance. This assessment is made in consideration that the paving is precast concrete flags, likely to have replaced original York stone components, and the landscaped strip between the paving and boundary wall is largely self-seeded bushes and trees, the roots of which have displaced the paving in the area to be occupied by the ramp.

#### 3.00 ASSESSMENT OF THE IMPACT OF THE PROPOSALS

#### 3.01 The Impact of the Proposals on the Affected Parts, and the Church Building as a Whole

The proposals will impact positively on both the setting and the use of the building, access to which for people with disabilities or wheelchair users is currently limited. Materials used for the ramp will be sympathetic to those used on the building, with red sandstone used for the retaining element of the construction, and to house the steel supports for the handrail, with visually contrasting surfaces of resin bound gravel and York stone used for the ramp surfaces and landings respectively. The intervention is small in scale, so the visual impact of the proposal is minimal.

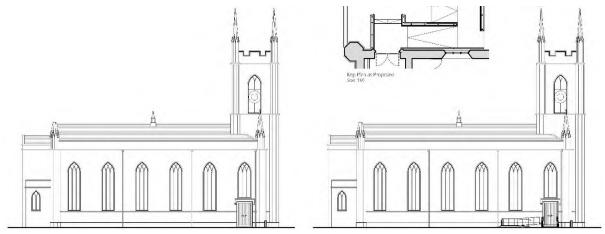

St. James, Latchford: North Elevation as Existing (L) and as Proposed (R).

#### 3.02 Mitigation

The use of sympathetic, quality materials should mitigate any potential negative impact of the proposals on the Heritage Asset, whilst the confines of available space and limited rise requirements dictate that the intervention will be of relatively small scale.



#### ST. JAMES, LATCHFORD: WORKS TO PROVIDE DISABLED ACCESS: STATEMENT OF NEED

#### 1.00 General Information

The parish church of St James, Latchford, is an early Victorian building, constructed between 1826 and 1828 to the designs of Liverpool Architect Samuel Rowland. For full descriptive details of the building and an assessment the significance of the church generally together with the specific areas affected by these proposals refer to the 'Statement of Significance' which supports this submission.

The principal access into the building is via a double door in the westernmost bay of the north Nave wall, which leads into a lobby which formerly contained stairs up to a long since removed gallery. 2 no. steps lead up to the door, which makes access difficult for the elderly and anyone with impaired mobility, and impossible for users of wheelchairs without the use of a temporary ramp, the gradient of which does not comply with current Building Regulations or DDA legislation.

A second entrance, in the corresponding southern location, appears to be largely unused. Other, single leaf, external doors giving access to the Lady Chapel in the easternmost bay of the south Nave wall, and Choir Vestry to the north of the Chancel, are also similarly little used, but also have the same stepped approaches which preclude unassisted access for wheelchair users.

Whilst, in theory, it would be possible to adapt any of the building's entrances for wheelchair use, the north door is considered as being the most appropriate for this purpose for the following reasons:



The north door to St James.


- It is the closest to designated parking for the building, including for disabled use
- Being the principal entrance to the church the use of other doors may be considered as discriminatory in terms of DDA legislation
- Levels, paths, and space around the door make this the logical place to site any ramp

#### 2.00 The Need for the Proposed Works

The church needs a permanent ramp to allow wheelchair and push-chair access for both parishioners and community groups who use the building. Currently, disabled people may only enter the building by means of a temporary ramp which requires two people to lift and is very steep and difficult to use unassisted. This makes the church unattractive to both disabled people and young families and may discourage some people and community groups from using the building at a time when the church are actively seeking to maintain the recent growth experienced in both service attendance and use by the wider community.

#### 3.00 The Proposals

It is proposed that a permanent ramp be constructed to address the north door (as seen in the Plan drawing at the top of the next page), which would allow wheelchair access. The ramp would be wholly located inside the current boundary wall, so would not require any additional land, and, as the north door functions as the principal access to the church, the proposals allow the main entrance to be used by both wheelchair users and able bodied alike, so cannot be considered discriminatory in the eyes of DDA legislation.

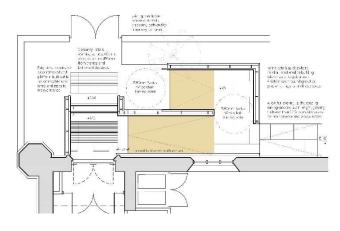

Plan of the Proposed Ramp.

Section 2.02 of the supporting Statement of Significance notes that the proposals directly abut the entrance door and a limited area at the west end of the north Nave wall, neither being significantly altered by the proposals. The hard landscaped area on which the ramp will stand is deemed to have Low / Neutral significance, an assessment made knowing that the current precast paving is likely to have replaced original York stone components, and the landscaped strip between the paving and boundary wall comprises largely self-seeded bushes and trees, the roots of which have displaced the paving in the area to be occupied by the ramp.

#### 4.00 Why the Church Needs to Undertake the Works Now

Unlike many other churches, St James, Latchford, has experienced an increase in attendance at services and in community use during the week, both immediately before the Covid 19 lockdowns and subsequently. Recent re-ordering of the interior has created a valuable space capable of supporting the activities of number of local societies and community groups, whilst the appointment of a priest-in-charge at the beginning of the year has also created additional interest in the local community.

This growth has been achieved despite the building being relatively remote from the nearby residential areas. A new housing estate, however, is planned on land immediately adjacent to the church, including that currently occupied by the bus depot to the north-east of the building. This will contain approximately 350 houses and has the potential to both increase the congregation considerably and cater for further use by the local community in the near future.



Google Maps image of the church's urban setting. The bus depot to the north will be demolished for housing.

All these developments, combined with the legal requirement to make a 'reasonable adjustment' to cater for the access needs of disabled people make the construction of a ramp in the very near future highly desirable, and is considered vital to maintaining growth and capitalising on any future opportunities presented by the planned developments. The church wants to make its services accessible to all and cater for flexible use by both able bodied members of the community and those with disabilities. This can only be achieved at St James with the addition of a ramp.


The provision of a ramp, by catering for access for all, will help secure a sustainable future for the whole parish, encouraging church attendance and accommodating greater community use. This will, in turn, generate much needed income towards the upkeep of the building and strengthen St. James position at the heart of the community once more.

#### 5.00 The Evidence for the Need

The proposals form part of a wider scheme to reorder the west end of the church, updating and improving existing facilities to better equip the building to serve the needs of C21st worship and flexible usage by the wider community.

Whilst the need for improvements to facilities and access is confirmed by the escalation in service attendance and community use, immediately available finance will not allow undertaking the work as a single project. The more urgent need is to make the building accessible to all, so completion of the ramp is seen as a priority.

This matter was discussed at a meeting of the Parochial Church Council on 19th August 2021, and a resolution was passed authorising the provision of a ramp to the north door (see copy minutes submitted in support of this application).

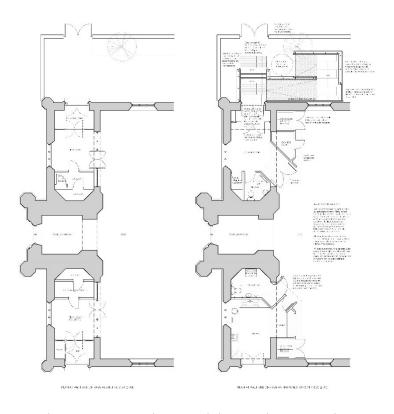

Plans as Existing and Proposed showing the ramp in the context of the west end reordering scheme.

#### 6.00 The Proposals and Environmental Sustainability


Being wholly external to the building the proposals have little part to play in reducing the carbon footprint of the church or contributing to the Parish's commitment to be 'net zero carbon' by 2030. The works will, however, rely heavily on the use of traditional materials, which, by nature, have relatively low carbon loadings and, if maintenance schedules are adhered to, should prove to be durable, reducing the need for intervention or replacement in the longer term.

In addition to this the introduction of the ramp, by providing access for all, will help secure a sustainable future for the parish and their building, by facilitating inclusive use of the building and generating income.

#### 7.00 Other Options Considered to Meet the Need

Provision of disabled access to the church could only have been achieved by 2 no. means, DDA compliant ramp or platform lift. The 340mm rise between external paving level and the north door threshold meant that a ramped solution was always going to be the favoured option, balancing the relatively short length of ramp required against the capital and on-going maintenance costs of installing a lift.

The location of the lift was also largely predetermined by the north door being the principal entrance to the church and closest to available designated parking. Options considered for the ramp in this location included straight flight and dog leg solutions, the latter, whilst taking more space, was preferred as this form minimises the length of travel necessary for wheelchair users to reach the doors.

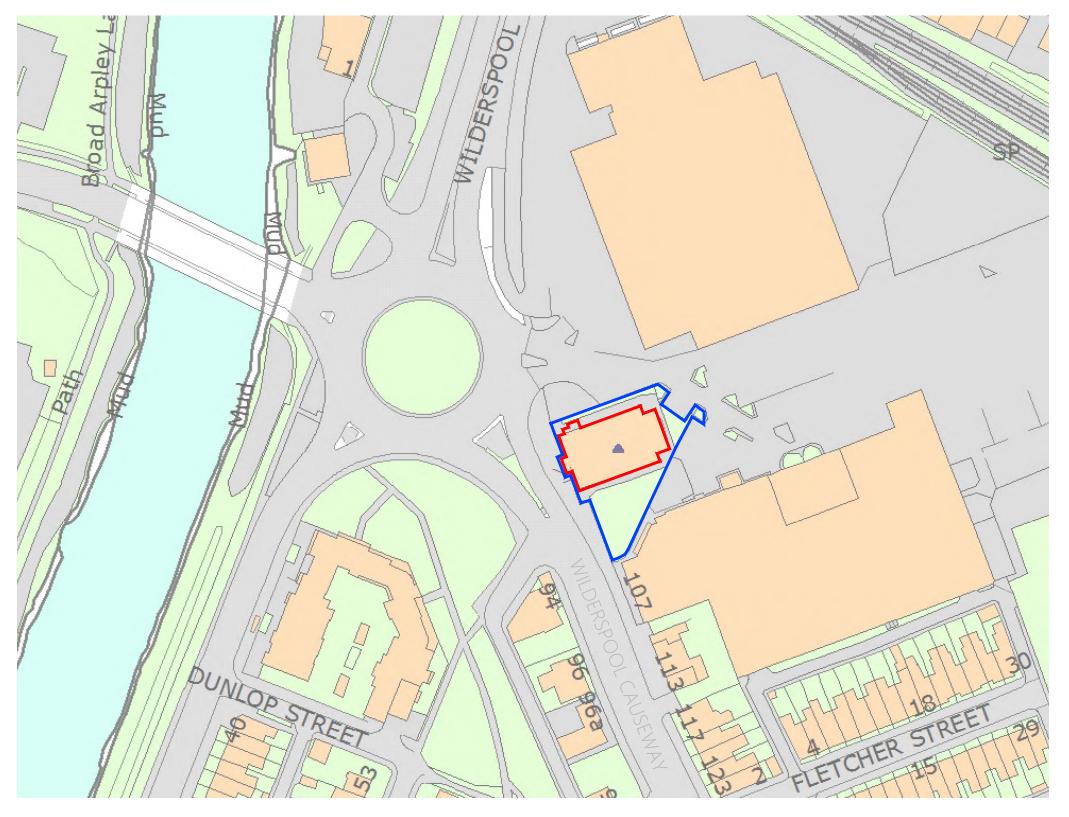

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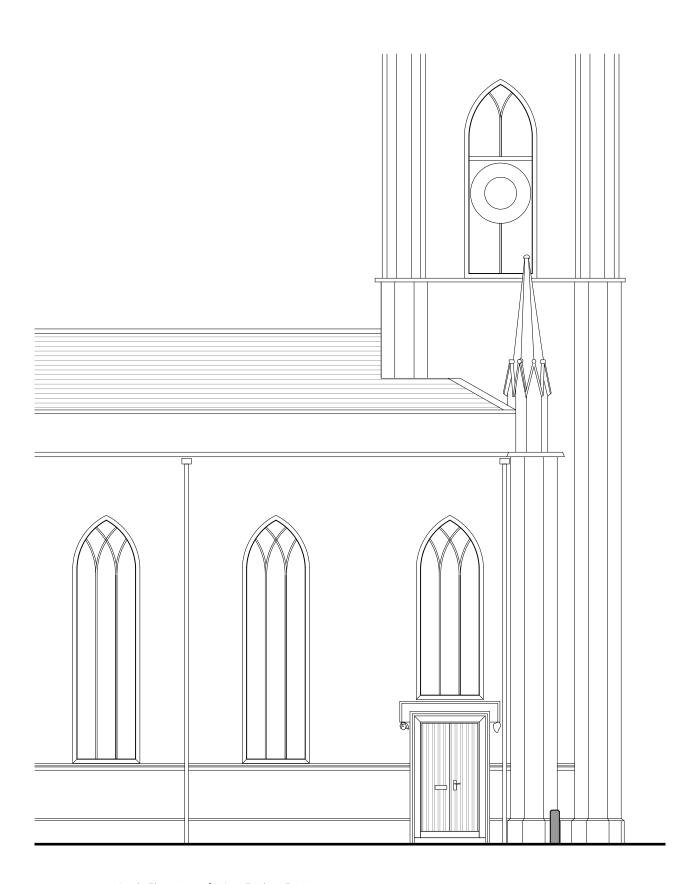
ST JAMES CHURCH \_\_\_\_\_\_
SITE BOUNDARY \_\_\_\_\_

### PLANNING & BUILDING CONSENT ISSUE


LBC4	Ash.K	Building boundary line amended	20/09/2022
PLBC3	Ash.K	General note "DO NOT SCALE" removed, in line with Planning Officer request	13/09/2022
PLBC2	Ash.K	SCALE of the drawing amended.	12/09/2022
LBC 1	Ash.K	PLANNING & BUILDING CONSENT ISSUE	29.06.2022
Rev.	Initial	Comments	Date

Contract St James, Latchford Location Plan 01 The Parochial Church Council Drawing No. Contract No. 2031A FDS Building / St. James Latchford: West End Structure 1:1250 @ A3 Jun 2022 PLBC4 KEPCZYK PEARCE SANDERSON Address: 75 Wilmslow Road, Handforth, Cheshire SK9 3EN Tel: 01625 400103 ARCHITECTS, SURVEYORS & HISTORIC BUILDING CONSULTANTS

Location Plan Scale 1:1250




North Elevation of West End as Existing Scale 1:100

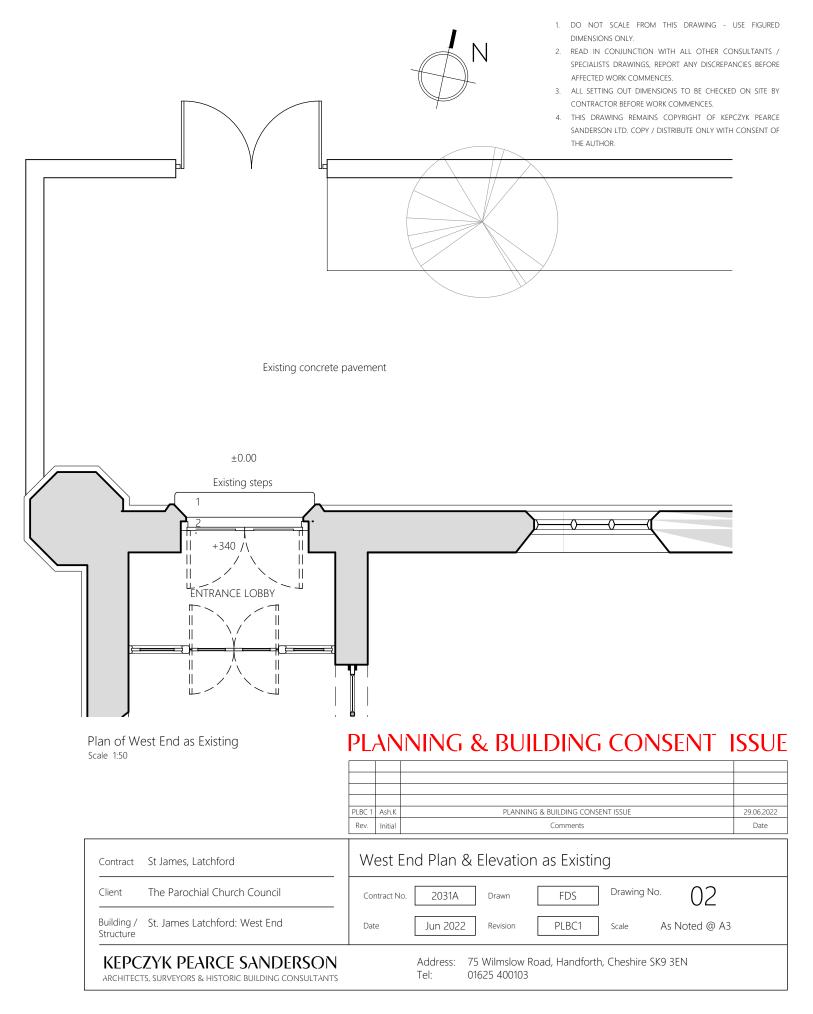



- DO NOT SCALE FROM THIS DRAWING USE FIGURED DIMENSIONS ONLY.
- READ IN CONJUNCTION WITH ALL OTHER CONSULTANTS / SPECIALISTS DRAWINGS, REPORT ANY DISCREPANCIES BEFORE AFFECTED WORK COMMENCES
- ALL SETTING OUT DIMENSIONS TO BE CHECKED ON SITE BY CONTRACTOR BEFORE WORK COMMENCES.
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  SANDERSON LTD. COPY / DISTRIBUTE ONLY WITH CONSENT OF
  THE ALITHOR

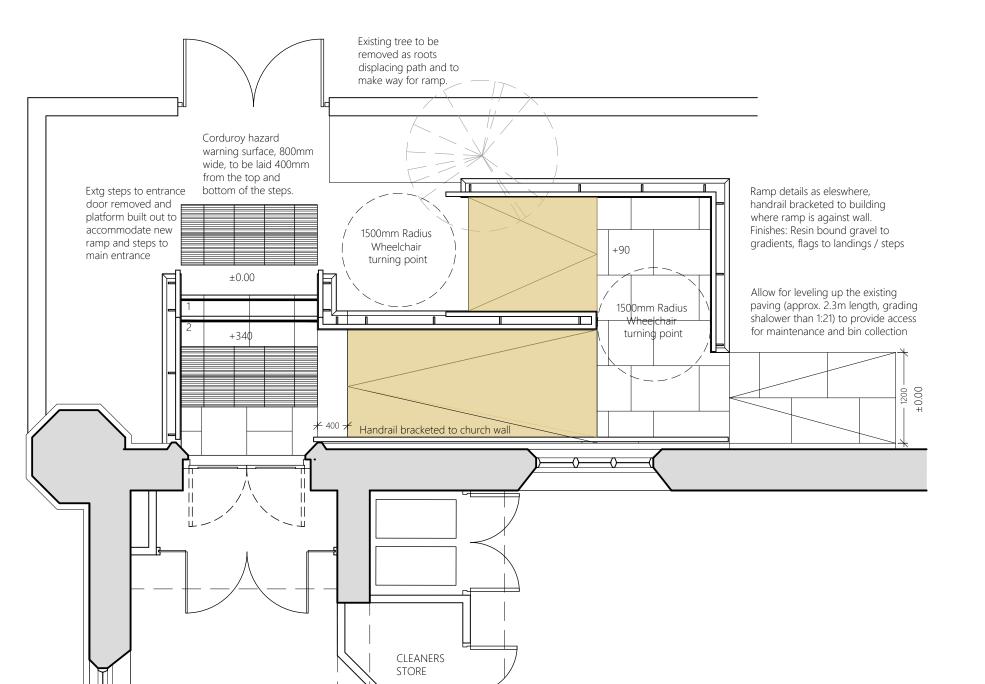


Plan of West End Ramp as Proposed


Scale 1:50

#### KEY TO RAMP FINISHES:

600 x nominal 75mm thick x random length Riven Yorkstone paving flags, 'Grange' range by Bingley stone, as NBS Q25/110, or equal to CA approval, solid bedded on 30mm 1:3 lime mortar and pointed in the same mix, on 150mm well compacted hardcore.

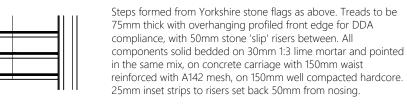

'SureSet' Resin Bound Paving, 'Permeable Pathway (SUDS)', comprising 16mm surface course of SureSet aggregate (max size 6mm) hand applied and trowelled to a smooth finish, on 60mm binder course of AC 14 open surf asphalt concrete max 100/150 pen to BS EN 13108-1: 2006, laid in well compacted layers, on geotextile membrane, on 150mm well compacted granular sub base Type 3 to SHW clause 805 or 4/40, 4/20 graded crushed concrete aggregate to BS EN12620 blinded with 2/6.3mm graded concrete aggregate to BS EN12620, laid to falls and gradients indicated, on geotextile membrane, on excavated sub grade. See NBS Q23/110A.

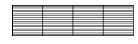

400x400x50mm corduroy hazard warning paving, Contractor's choice to CA approval, solid bedded on 30mm 1:3 lime mortar and pointed in the same mix, on 150mm well compacted hardcore.

### PLANNING & BUILDING CONSENT ISSUE

PLBC 1	Ash.K	Planning & Building Consent issue	29.06.2022
Rev.	Initial	Comments	Date
1			

Contract St James, Latchford Plan of West End Ramp as Proposed

Client The Parochial Church Council Contract No. 2031A Drawn FDS Drawing No. 03

Building / St. James Latchford: West End Date Jun 2022 Revision PLBC1 Scale 1:50 @ A3

KEPCTYK PEARCE SANDERSON Address: 75 Wilmslow Road, Handforth, Cheshire SK9 3EN


KEPCZYK PEARCE SANDERSON ARCHITECTS, SURVEYORS & HISTORIC BUILDING CONSULTANTS

Address: 75 Wilmslow Road, Handforth, Cheshire SK9 3EN Tel: 01625 400103



North Elevation as Existing Scale 1:200


NOTE:
PLEASE SEE DRAWING 03 FOR ARCHITECT CONSTRUCTION
DETAILS AND FINISHES.
THIS DRAWINGS SHOULD BE READ IN CONJUNCTION WITH
STRUCTURAL ENGINEER'S DRAWINGS AND SPECIFICATION.

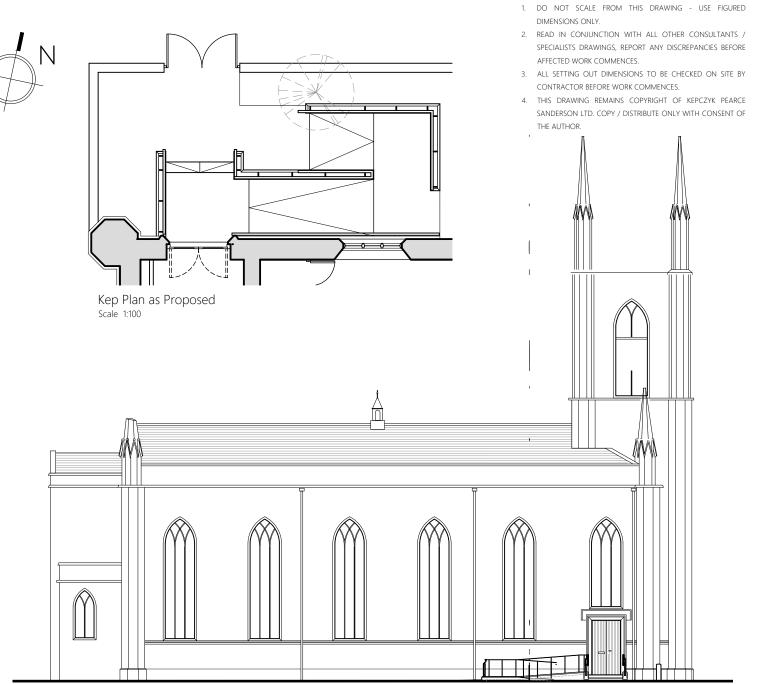


North Elevation as Proposed Scale 1:200

## PLANNING & BUILDING CONSENT ISSUE


	PLBC 1 Rev.	Ash.K Initial	PLANNING & BUILDING CONSENT ISSUE  Comments	29.06.2022 Date
Contract St James, Latchford	No	orth	Elevation as Existing & Proposed	
Client The Parochial Church Council	Cor	ntract No	o. 2031A Drawn ASH.K Drawing No. 04	
Building / St. James Latchford: West End Structure	Dat	e	Jun 2022 Revision PLBC1 Scale As Noted @ A3	
KEPCZYK PEARCE SANDERSON ARCHITECTS, SURVEYORS & HISTORIC BUILDING CONSULTANTS			Address: 75 Wilmslow Road, Handforth, Cheshire SK9 3EN Tel: 01625 400103	

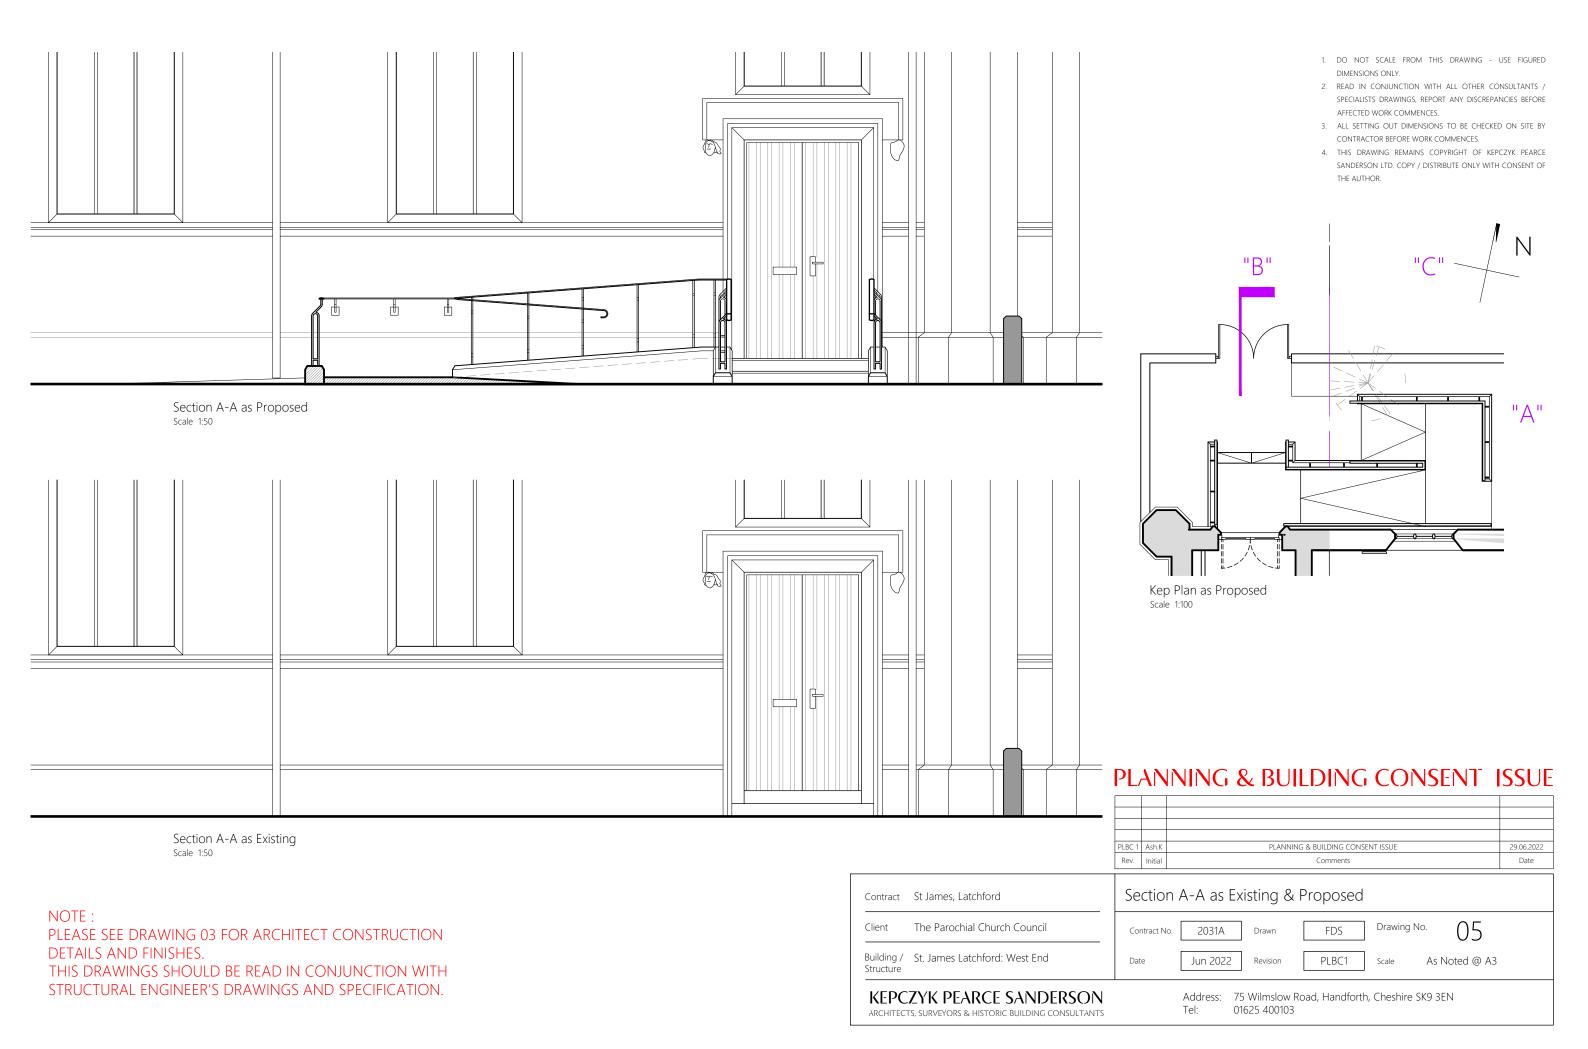

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- 2. READ IN CONJUNCTION WITH ALL OTHER CONSULTANTS / SPECIALISTS DRAWINGS, REPORT ANY DISCREPANCIES BEFORE AFFECTED WORK COMMENCES.
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Section B-B as Proposed Scale 1:50

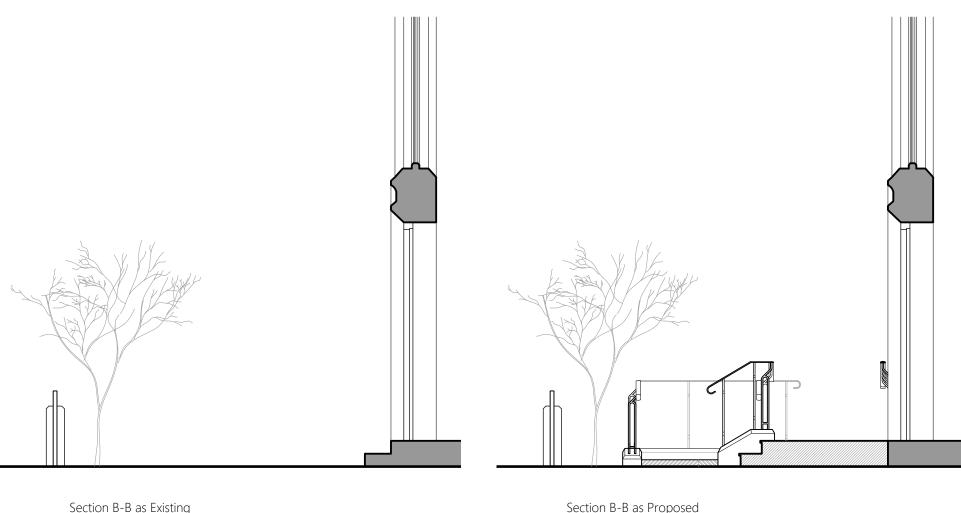

Kep Plan as Proposed Scale 1:100
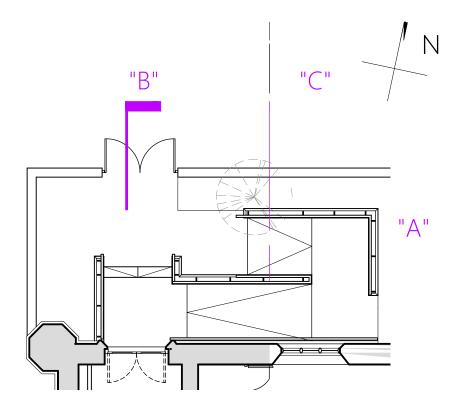
## PLANNING & BUILDING CONSENT ISSUE

PLBC 1	Ash.K	Planning & Building Consent Issue	29.06.2022
Rev.	Initial	Comments	Date


Section B-B as Existing & Proposed Contract St James, Latchford 06 The Parochial Church Council Drawing No. 2031A FDS Building / St. James Latchford: West End As Noted @ A3 Jun 2022 PLBC1 Structure **KEPCZYK PEARCE SANDERSON** Address: 75 Wilmslow Road, Handforth, Cheshire SK9 3EN Tel: 01625 400103 ARCHITECTS, SURVEYORS & HISTORIC BUILDING CONSULTANTS

Scale 1:50

PLEASE SEE DRAWING 03 FOR ARCHITECT CONSTRUCTION DETAILS AND FINISHES.

THIS DRAWINGS SHOULD BE READ IN CONJUNCTION WITH STRUCTURAL ENGINEER'S DRAWINGS AND SPECIFICATION.

- DO NOT SCALE FROM THIS DRAWING USE FIGURED DIMENSIONS ONLY.
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"B"
"A"

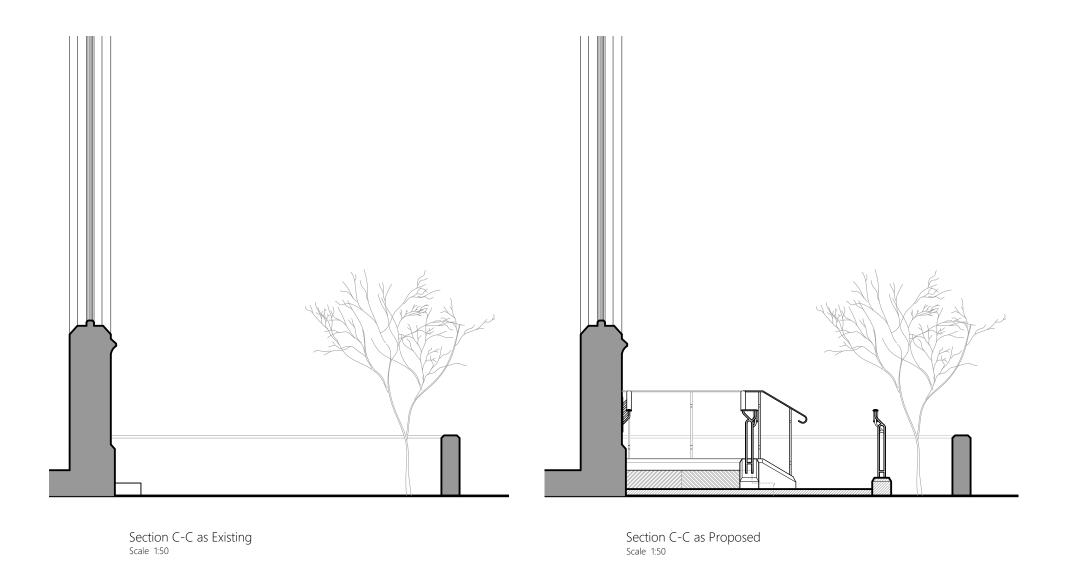
Kep Plan as Proposed Scale 1:100

## NOTE: PLEASE SEE DRAWING 03 FOR ARCHITECT CONSTRUCTION DETAILS AND FINISHES.

THIS DRAWINGS SHOULD BE READ IN CONJUNCTION WITH STRUCTURAL ENGINEER'S DRAWINGS AND SPECIFICATION.

## PLANNING & BUILDING CONSENT ISSUE

	PLBC 1 A	sh.K PLANNING & BUILDING CONSENT ISSUE 29.06.2022
		sh.K PLANNING & BUILDING CONSENT ISSUE 29.06.2022 itial Comments Date
Contract St James, Latchford	Sec	tion C-C as Existing & Proposed
Client The Parochial Church Council	Contra	act No. 2031A Drawn FDS Drawing No. 07
Building / St. James Latchford: West End Structure	Date	Jun 2022 Revision PLBC1 Scale As Noted @ A3
KEPCZYK PEARCE SANDERSON ARCHITECTS, SURVEYORS & HISTORIC BUILDING CONSULTANTS		Address: 75 Wilmslow Road, Handforth, Cheshire SK9 3EN Tel: 01625 400103

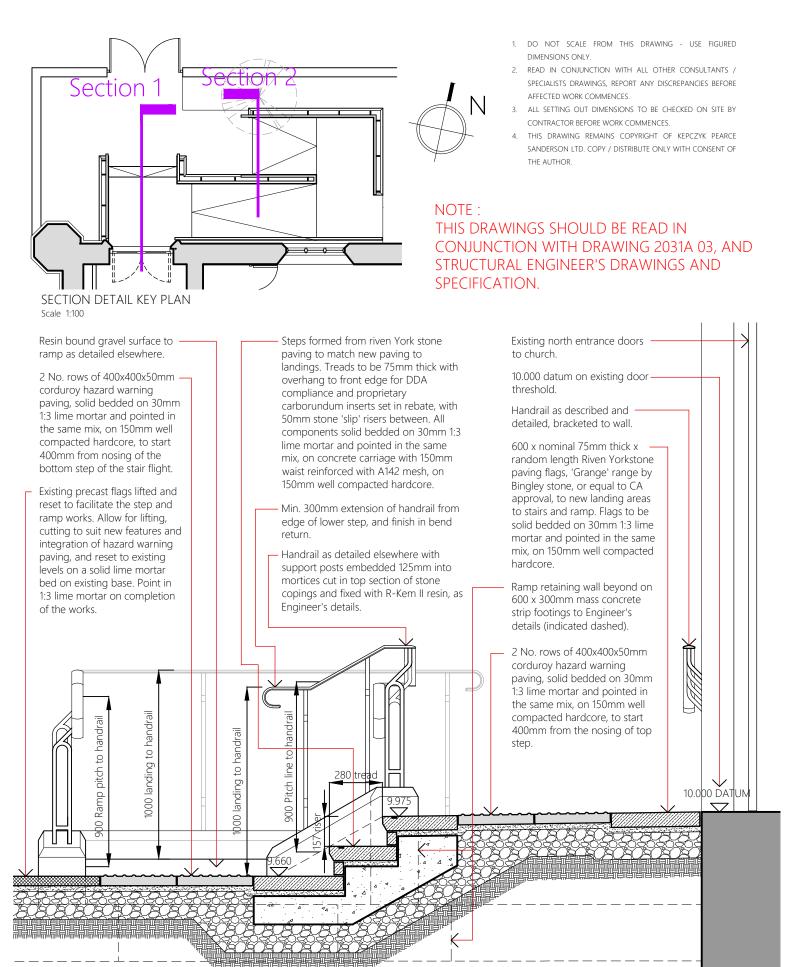


DETAILED SECTION 1 - 1 THROUGH STEPS AND LANDING OUTSIDE DOORS

Scale 1:20

60x15mm bronze profiled handrail to Ramp surfaces to be 'Permeable Pathway (SUDS)' by SureSet lower flight of ramp with support leg Resin Bound Paving, comprising 16mm surface course of welded to standard leg assembly as noted. SureSet aggregate (max size 6mm) hand applied and trowelled to a smooth finish, on 60mm binder course of AC Steps beyond indicated dashed. 60x15mm bronze profiled 14 open surf asphalt concrete max 100/150 pen to BS EN handrail with beveled top All joints in ramp wall 13108-1: 2006, laid in well compacted layers, on geotextile edge and turned ends to masonry to be membrane, on 150mm well compacted granular sub base radius as noted. Handrail reinforced with 2 no. Type 3 to SHW clause 805 or 4/40, 4/20 graded crushed to be fully secured to M16 s/s dowels @ concrete aggregate to BS EN12620 blinded with 2/6.3mm legs (detail to be agreed). 450mm c/cs, fixed as graded concrete aggregate to BS EN12620, laid to falls and Support legs to handrail Engineer's details. gradients indicated, on geotextile membrane, on excavated to be formed from sub grade. 20x20mm black polyester Handrail and leg support powder coated stainless detail as described. steel square sections  $\wedge$ Nominal 300x250mm welded to profiles indicated, and with all red sandstone (to match visible excess weld building masonry) removed. Legs to be copings to ramp retaining walls with secured min. 125mm into mortices cut in the stone twice chamfered tops. All components of walls coping sections of the to be dowelled flanking walls, and resin together (including to fixed to Engineer's detail. footings) in accordance Resin bound gravel with Engineer's details. step / r to top surface to ramp as 600x300mm mass described. 1000mm concrete strip footings to Engineers details, top face set nominal 150mm below existing paving level Extend down in mass concrete fill to below topsoil root depth if necessary. · 4

DETAILED SECTION 2 -2 THROUGH RAMP SURFACE AND RETAINING WALLS



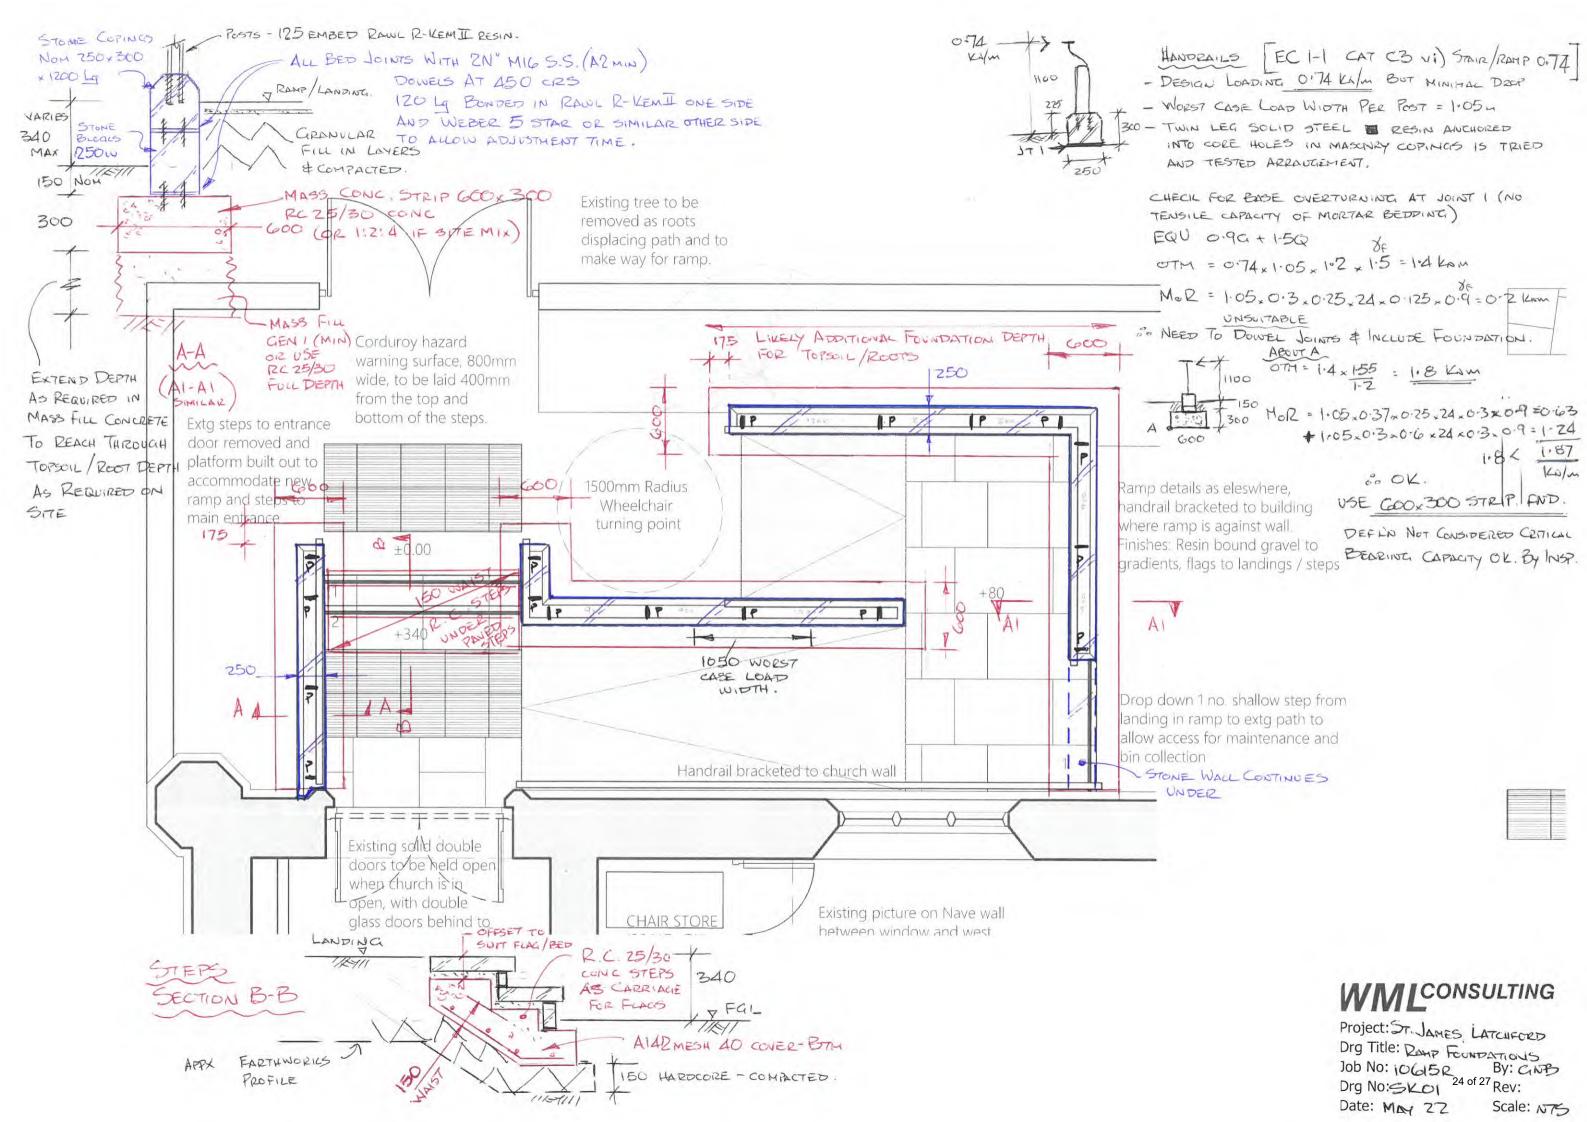



## Schedule of Works

Items	Joynu nearts and minds	£	р
1.	Site preparation, securing the site. Protection of existing doors and other vulnerable surfaces/fittings and equipment.	£3100	
2.	Break up existing steps and remove from site	£450	
3.	Excavate the area of proposed ramp, allow for investigation and diverting/ altering the existing drainage.	£3600	
4.	Construct foundation for new access ramp and steps as structural engineer drawings and specifications.	£4500	
5.	Construct new access ramp and steps as detailed inc. handrail to details. Masonry superstructure to Architect details.	£25,000	
6.	Preliminaries and insurances.	£1500	9
	PROVISIONAL SUMS AND CONTINGENCIES		
Additio	nal hard and soft landscape (Prov)	1000	00
Additio	nal drainage works (Prov)	500	00
Conting	deucies you whanks and praise,	3000	00
TO FO	RM OF TENDER	* .	
Sado	dleworth restoration conservation ltd	£42,650 + vat	
Andr	rew Sharp		
LITT	up your hearts lift them to the Lord	\\	
1412	Spirit is with us		

Latchford St James – Access ramp - Correspondence with parish and others

Attachments are listed according to the numbering on the supporting documents list

- Attachments in purple are in the overview section
- Attachments in blue are included within the proposals section
- Strikethrough text relates to a separate application, italic text refers to superseded or unnecessary attachments

Date	Message
30/11/2022	Further to our telephone conversation earlier please find attached our
	Statements of Significance and Need, drawings, and the Structural
To: Katy Purvis	Engineer's drawings in respect of the above. I understand that the
From: Duncan	Parish will need to formally apply rather than ourselves as they need to
Sanderson of	raise the petition, but this is the supporting information.
Kepczyk, Pearce,	
Sanderson, Robert	Rob: Katy said she would give you a call regarding the application,
Icke	which, technically, we are unable to lodge, but the DAC now have all the
	information other than the petition. If you need anything else from us
With	please let me know.
attachments:	
	2) Statement of Significance of Kepczyk Pearce Sanderson dated July 2022
30/11/2022	3) Statement of Need of Kepczyk Pearce Sanderson dated August 2022 4) Drawings of Kepczyk Pearce Sanderson numbered 01 Location Plan (dated 20/09/2022), 02 West End Plan & Elevation as Existing (dated 29/06/2022), 03 Plan of West End Ramp as Proposed (dated 29/06/2022), 04 North Elevation as Existing & Proposed (dated 29/06/2022), 05 Section A-A as Existing & Proposed (dated 29/06/2022), 06 Section B-B as Existing & Proposed (dated 29/06/2022), 07 Section C-C as Existing & Proposed (dated 29/06/2022) and 08 Section Details Through Proposed Ramp dated August 2022 5) Drawing number SK01 Ramp Foundations of WML Consulting dated May 2022 Thanks Duncan, Rob and I have just discussed this, all good to go. It's on the agenda for December in anticipation of a formal application being
To: Duncan	ready by then
Sanderson of	
Kepczyk, Pearce,	
Sanderson, Robert	
Icke	
From: Katy Purvis	
22/12/2022	DAC Advice
T D L	I am writing to let you that at its meeting of 16 December 2022, the DAC
To: Robert Icke,	considered the proposal for the ramp and resolved to recommend the
Duncan	scheme with the following provisos:
Sanderson of	
Kepczyk, Pearce,	a. The works to be under the direction and subject to the inspection of
Sanderson	the Scheme Architect
From: Katy Purvis	b. The parish to obtain any necessary planning consents

The Committee also wished to offer the following informal advice a. The parish should ensure the path around the building is safe and accessible
If you have any queries please do let me know.